

POWER SYMBOLS

	ATS	AUTOMATIC TRANSFER SWITCH
	400 AF 400 AT	MOLDED CASE CIRCUIT BREAKER 400A FRAME RATING 400A TRIP RATING
		GROUND CONNECTION
		METER PER UTILITY REQUIREMENTS
		120/208V POWER/LIGHTING PANEL
		FIRE ALARM CONTROL PANEL
		GROUND FAULT INTERRUPTER, QUADRUPLEX RECEPTACLE, 20A,125V. 42" AFF UNLESS OTHERWISE INDICATED
		DUPLEX RECEPTACLE, 20A, 125V, 24" AFF IN OFFICE CORE, UNLESS OTHERWISE INDICATED
		BLOCK HEATER RECEPTACLE
		GROUND FAULT INTERRUPTER, DUPLEX RECEPTACLE, 20A,125V. 42" AFF UNLESS OTHERWISE INDICATED "+" INDICATES 6" ABOVE COUNTER TOP OR BACKSPLASH
		SPECIAL POWER OUTLET 208V, 3 PHASE, 42" AFF
		FLUSH MOUNTED FLOOR DUPLEX RECEPTACLE, 20A, 125V
		UNDERGROUND GROUNDING LOOP
		UNDERGROUND CONDUIT
		CONDUIT EXPOSED
	LP1-3	HOMERUN, LP1-3 DENOTES LIGHTING PANEL NO. 1, CIRCUIT #3
		EXISTING UTILITY POLE
		PROPOSED UTILITY POLE
	DS PB WP GFI	EXHAUST FAN WITH WP GFI
		PROPELLER FAN, PLAN VIEW
		PROPELLER FAN SPEED CONTROL. "a" INDICATES FAN(S) CONTROLLED
		OVERHEAD DOOR OPERATOR
		PUSHBUTTON STATION
	M 2	MOTOR AMPERE RATING AND HORSEPOWER AS INDICATED
		MOTOR STARTER
		COMBINATION MOTOR STARTER
		DISCONNECT SWITCH, AMPERE RATING AS INDICATED
	F 30A	FUSED DISCONNECT SWITCH, AMPERE RATING AS INDICATED
		CONCRETE HANDHOLE
	J J	JUNCTION BOX
	PB	PULL BOX
		BRINE SYSTEM RECEPTACLE
	AT	AUTOTRANSFORMER
		TRANSFORMER, RATING AS INDICATED

SYMBOLS

	SP	PUBLIC ADDRESS SPEAKER - CEILING MOUNTED
	HS	PUBLIC ADDRESS SPEAKER - WALL MOUNTED
		COMMUNICATION OUTLET BOX (VOICE AND DATA), 18" AFF UNLESS OTHERWISE INDICATED
	W	COMMUNICATION OUTLET BOX (VOICE AND DATA) "W" DENOTES WALL HUNG TELEPHONE (48" AFF)
		BASE RADIO FOUNDATION, POLE, AND ANTENNA
	PC	PHOTOCELL
	S	SWITCH BOX WITH SINGLE AUTO/MANUAL SWITCH
	LO LP2-3	ALUMINUM POLE WITH 250W, HPS SPOT LUMINAIRE. "LO" INDICATES FIXTURE TYPE. "LP2-3" INDICATES PANEL AND CIRCUIT NUMBER. SEE LIGHTING FIXTURE SCHEDULE ON DRAWING NO. E-XXX FOR POLE INFORMATION.
	L2 LP2-8	ALUMINUM POLE WITH TENON BRACKET FOR TWO 150W, HPS LUMINAIRES. "LO" INDICATES FIXTURE TYPE. "PP2-8" INDICATES POWER PANEL NO. 2 AND CIRCUIT NO. 8. SEE LIGHTING FIXTURE SCHEDULE ON DRAWING NO. E-XXX FOR POLE INFORMATION.
	L1, L2 LP2-3	ALUMINUM POLE WITH 150W, HPS LUMINAIRE AND ARM-BRACKET. "L1" AND "L2" INDICATES FIXTURE TYPE. "LP2-3" INDICATES PANELS AND CIRCUIT NUMBER. SEE LIGHTING FIXTURE SCHEDULE ON DRAWING NO. E-XXX FOR POLE INFORMATION.
	L2 LO LP2-3	ALUMINUM POLE WITH TENON BRACKET FOR TWO HPS LUMINAIRES (ONE SPOT AND ONE COBRA) "LO, L2" INDICATES FIXTURE TYPE. "PP2-8" INDICATES POWER PANEL NO. 2 AND CIRCUIT NO. 8. SEE LIGHTING FIXTURE SCHEDULE ON DRAWING NO. E-XXX FOR POLE INFORMATION.
	G1	FLAG POLE LIGHT
	SL	SHOWER LIGHT
	D a LP2-7	WALL MOUNTED HIGH PRESSURE SODIUM (METAL HALIDE LIGHTING FIXTURE "D" INDICATES FIXTURE TYPE, "LP2-7" INDICATES PANEL AND CIRCUIT NUMBER, "a" INDICATES SWITCHING CIRCUIT)
	B, B1, B2, B2E LP2-3	RECESS MOUNTED FLUORESCENT FIXTURE ("B", "B1", "B2", AND "B2E" INDICATES FIXTURE TYPE, "LP2-3" INDICATES PANEL AND CIRCUIT NUMBER, AND CIRCUIT NUMBER, "a" INDICATES SWITCHING CIRCUIT)
	A, C LP2-3	PENDANT FLUORESCENT LIGHTING FIXTURE ("A" AND "C") INDICATES FIXTURE TYPE, "LP2-3" INDICATES PANEL AND CIRCUIT NUMBER, AND CIRCUIT NUMBER, "a" INDICATES SWITCHING CIRCUIT)
	X	WALL MOUNTED LED EXIT SIGN WITH SELF- CONTAINED NI-CAD BATTERY PACK AND CHARGER
	X2	CEILING MOUNTED DOUBLE FACE DIRECTIONAL LED EXIT SIGN WITH SELF-CONTAINED NI-CAD BATTERY PACK AND CHARGER.
	EM	EMERGENCY LIGHTING UNIT WITH BATTERY PACK
	I	MIRROR LIGHT LUMINAIRE (LETTER INDICATES FIXTURE TYPE)
	EMR	WEATHERPROOF BATTERY OPERATED EMERGENCY EGRESS REMOTE HEAD

COMMUNICATION SYMBOLS

	SP	PUBLIC ADDRESS SPEAKER - CEILING MOUNTED
	HS	PUBLIC ADDRESS SPEAKER - WALL MOUNTED
		COMMUNICATION OUTLET BOX (VOICE AND DATA), 18" AFF UNLESS OTHERWISE INDICATED
	W	COMMUNICATION OUTLET BOX (VOICE AND DATA) "W" DENOTES WALL HUNG TELEPHONE (48" AFF)
		BASE RADIO FOUNDATION, POLE, AND ANTENNA

LIGHT FIXTURE SYMBOLS

	PC	PHOTOCELL
	S	SWITCH BOX WITH SINGLE AUTO/MANUAL SWITCH
	LO LP2-3	ALUMINUM POLE WITH 250W, HPS SPOT LUMINAIRE. "LO" INDICATES FIXTURE TYPE. "LP2-3" INDICATES PANEL AND CIRCUIT NUMBER. SEE LIGHTING FIXTURE SCHEDULE ON DRAWING NO. E-XXX FOR POLE INFORMATION.
	L2 LP2-8	ALUMINUM POLE WITH TENON BRACKET FOR TWO 150W, HPS LUMINAIRES. "LO" INDICATES FIXTURE TYPE. "PP2-8" INDICATES POWER PANEL NO. 2 AND CIRCUIT NO. 8. SEE LIGHTING FIXTURE SCHEDULE ON DRAWING NO. E-XXX FOR POLE INFORMATION.
	L1, L2 LP2-3	ALUMINUM POLE WITH 150W, HPS LUMINAIRE AND ARM-BRACKET. "L1" AND "L2" INDICATES FIXTURE TYPE. "LP2-3" INDICATES PANELS AND CIRCUIT NUMBER. SEE LIGHTING FIXTURE SCHEDULE ON DRAWING NO. E-XXX FOR POLE INFORMATION.
	L2 LO LP2-3	ALUMINUM POLE WITH TENON BRACKET FOR TWO HPS LUMINAIRES (ONE SPOT AND ONE COBRA) "LO, L2" INDICATES FIXTURE TYPE. "PP2-8" INDICATES POWER PANEL NO. 2 AND CIRCUIT NO. 8. SEE LIGHTING FIXTURE SCHEDULE ON DRAWING NO. E-XXX FOR POLE INFORMATION.

FIRE ALARM SYMBOLS

	FS	FLOW SWITCH
	TS	TAMPER SWITCH
	PS	PRESSURE SWITCH
		FIRE ALARM BELL FOR SPRINKLER SYSTEM
	F	FIRE ALARM WITH STROBE LIGHT- SURFACE MOUNTED
	F	FIRE ALARM HORN WITH STROBE LIGHT- SURFACE MOUNTED
	F	FIRE ALARM PULL STATION - SURFACE MOUNTED 42" AFF. UNLESS OTHERWISE INDICATED.
	SD	SMOKE DETECTOR IONIZATION TYPE.
	2	DUCT MOUNTED SMOKE DETECTOR TO BE FURNISHED, WIRED, AND CONNECTED BY THE ELECTRICAL INSTALLER.

ABBREVIATIONS

A	AMPERE
AFF	ABOVE FINISHED FLOOR
AFG	ABOVE FINISHED GRADE
AHU	AIR HANDLING UNIT
AUTO	AUTOMATIC
AIC	AMPS INTERRUPTING CAPACITY
ATC	AUTOMATIC TEMPERATURE CONTROLLER
ATS	AUTOMATIC TRANSFER SWITCH
AWG	AMERICAN WIRING GAUGE
BAS	BUILDING AUTOMATION SYSTEM
BLDG	BUILDING
BRK.	BREAKER
C	CONDUIT
CKT.	CIRCUIT
COL.	COLUMN
CT	CURRENT TRANSFORMER
CU	COPPER
DISC.	DISCONNECT
DF	DRINKING FOUNTAIN
DP1	FUEL POWER PANEL
DWG	DRAWING
EDH	ELECTRICAL DUCT HEATER
EF	EXHAUST FAN
ELEC.	ELECTRICAL
ERV	ROOF VENTILATOR, EXHAUST
EUH	ELECTRICAL UNIT HEATER
FA	FIRE ALARM
FACP	FIRE ALARM CONTROL PANEL
FL	FLOOR
G.C.	GENERAL CONTRACTOR
GEN	GENERATOR
GFI	GROUND-FAULT INTERRUPTER
G, GND	GROUND
HID	HIGH INTENSITY DISCHARGE
HP	HORSEPOWER
HPS	HIGH PRESSURE SODIUM
HT.	HEIGHT
HTR	HEATER
HZ	HERTZ
IN.	INCH
JB	JUNCTION BOX
KVA	KILOVOLT AMPERE
KW	KILOWATTS
LP	LIGHTING PANEL
MDP	MAIN DISTRIBUTION POWER PANEL
MECH	MECHANICAL
MH	METAL HALIDE
MTG. HT.	MOUNTING HEIGHT
NEC	NATIONAL ELECTRICAL CODE
N.C.	NORMALLY CLOSED
N.O.	NORMALLY OPEN
O.C.	ON CENTER
PB	PUSH BUTTON
PF	PADDLE FAN
PIR	PASSIVE INFRARED
P.V.C.	POLYVINYL CHLORIDE CONDUIT
PF	POWER FACTOR
PP	POWER PANEL
PNL	PANEL
RM	ROOM
REC	RECEPTACLE
RGS	RIGID GALVANIZED STEEL
RP	RECEPTACLE PANEL
RTAC	ROOF TOP AIR CONDITIONER
SPECS	SPECIFICATIONS
S ¹ X ¹	SWITCH, SINGLE POLE "X" INDICATES SWITCHING CIRCUIT
SW	SWITCH
3PH	THREE PHASE
3P	THREE POLE
TYP.	TYPICAL
UH	UNIT HEATER
UPS	UNINTERRUPTABLE POWER SUPPLY
V	VOLT
W	WATT OR WIRE
WP	WEATHERPROOF
XFMR	TRANSFORMER

SWITCH CONTROL SYMBOLS

S _{TP}	MANUAL STARTER WITH THERMAL PROTECTION AND PILOT LIGHT
Sk	KEY LOCK SWITCH, 3-WAY, "b" INDICATES SWITCHING CIRCUIT
S _{3b}	FAN SPEED CONTROL SWITCH
Sa	SWITCH, SINGLE POLE, "a" INDICATES SWITCHING CIRCUIT
S ₃	SWITCH, 3-WAY, "b" INDICATES SWITCHING CIRCUIT
S ₄	SWITCH, 4-WAY, "b" INDICATING SWITCHING CIRCUIT
S _T	THERMAL SWITCH, MANUAL STARTER

VIDEO MONITOR SYMBOLS

	VIDEO CAMERA
	VIDEO MONITOR


OCCUPANCY SENSORS

DEVICE	DESCRIPTION
1500	CEILING MOUNTED PIR, 1500 SQ FT
500	CEILING MOUNTED ULTRASONIC, 500 SQ FT
500	CEILING MOUNTED MULTI-TECHNOLOGY, 500 SQ FT
1000	CEILING MOUNTED MULTI-TECHNOLOGY, 1000 SQ FT
1000	CEILING MOUNTED ULTRASONIC, 1000 SQ FT
i	WALL MOUNTED PIR, 2000 SQ FT (i DENOTES CONTROLLED FIXTURES)
i	PIR BAY AREA SENSOR APPROXIMATELY 1000 SQ FT AT 18 FOOT MOUNTING HEIGHT (i DENOTES CONTROLLED FIXTURES)
w	PIR WASHBAY WET LOCATION SENSOR APPROXIMATELY 1000 SQ FT AT 18 FOOT MOUNTING HEIGHT
i	POWER PACK FOR 120/230/277VAC SYSTEM (i DENOTES CONTROLLED FIXTURES)
M S	WALL SWITCH MULTI-TECHNOLOGY, SELF POWERED

GENERAL NOTES:


- MINIMUM SIZE WIRE FOR POWER AND LIGHTING PANELS CIRCUITS SHALL BE #12 AWG. BRANCH CIRCUITS EXCEEDING 100 FEET IN LENGTH SHALL BE #10 AWG. WIRING SIZE SHALL BE ADJUSTED AS NECESSARY TO REFLECT AMPACITY DERATING DUE TO NUMBER OF LOADED CONDUCTORS SHARING A PARTICULAR RACEWAY. MINIMUM CONDUIT SIZE SHALL BE 3/4" AS OUTLINED IN SPECIFICATION SECTION 260533.
- INTERRUPTING CAPACITY OF ELECTRICAL EQUIPMENT SHALL BE EQUAL TO OR GREATER THAN THE AVAILABLE SHORT-CIRCUIT CURRENT AT ITS SUPPLY TERMINAL.
- INSTALLERS SHALL, IN A WORKMANLIKE MANNER, PROVIDE COMPLETE OPERABLE SYSTEMS.
- INSTALLER SHALL COORDINATE ALL WORK WITH OTHER DIVISION TRADES, LOCATE FIXTURES, DEVICES, ETC, IN ORDER TO AVOID INTERFERENCE.
- ALL FEEDER AND BRANCH CIRCUITS SHALL HAVE AN EQUIPMENT GROUND CONDUCTOR INCLUDED WITH PHASE WIRING.
- COMMUNICATION OUTLETS SHALL BE INSTALLED AND WIRED IN ACCORDANCE WITH EIA/TIA-568 STANDARDS.
- ELECTRICAL INSTALLER SHALL BE RESPONSIBLE FOR THE POWER WIRING FOR THE ENERGY MANAGEMENT SYSTEM. THE ELECTRICAL INSTALLER SHALL COORDINATE WITH BAS/ATC INSTALLER. ALL POWER FOR BAS/ATC CONTROLS TO COME FROM SAME UPS THAT POWERS THE BAS/ATC HEAD END.
- CONDUIT ROUTING SHOWN ON THE PLANS ARE ONLY DIAGRAMMATIC IN NATURE.
- ALL CIRCUITS SHALL HAVE SEPARATE NEUTRAL CONDUCTOR FROM ELECTRICAL PANELS.
- ALL CONDUITS AND BOXES IN OFFICE CORE AREA ONLY SHALL BE FLUSH MOUNTED FOR TEMPERATURE SENSORS ASSOCIATED WITH BAS SYSTEM.
- ALL PANELBOARDS SHALL BE MOUNTED ON 3/4" FIRE RETARDANT PLYWOOD, TREATED ON ALL SIDES, AND PAINTED WITH TWO COATS OF BLACK LAYER ENAMEL.
- INSTALL FIRE STOP AROUND ALL ELECTRICAL CONDUIT PENETRATIONS THROUGH FIRE RESISTANCE RATED WALLS.
- THE SPACE EQUAL TO THE WIDTH AND DEPTH OF SERVICE EQUIPMENT, SWITCHBOARDS, PANEL BOARDS, AND MOTOR CONTROL CENTERS EXTENDING UP FROM THE FLOOR TO A HEIGHT OF 6' ABOVE THE EQUIPMENT OR TO THE STRUCTURAL CEILING, WHICHEVER IS LOWER, SHALL BE DEDICATED TO THE ELECTRICAL INSTALLATION. FOREIGN SYSTEMS (SUCH AS WATER PIPING) INSTALLED DIRECTLY ABOVE THE DEDICATED SPACE MUST INCLUDE PROTECTIVE EQUIPMENT THAT INSURES THAT OCCURENCES SUCH AS LEAKS, CONDENSATION, AND BREAKS DO NOT DAMAGE ELECTRICAL EQUIPMENT BELOW. SEE NEC ARTICLE 110.26 FOR FURTHER DETAILS.

REV.	DATE	REVISION DESCRIPTION	SHEET NO.	Plotted Date: 9/14/2009	DESIGNER/DRAFTER: -	CHECKED BY: -	SCALE AS NOTED	<p>STATE OF CONNECTICUT DEPARTMENT OF TRANSPORTATION</p>	<p>Signature/Block: OFFICE OF ENGINEERING</p> <p>APPROVED BY: _____ DATE: _____</p>	PROJECT TITLE: SYMBOLS, ABBREVIATIONS, AND GENERAL NOTES	TOWN: -	PROJECT NO. -	DRAWING NO. E-001	SHEET NO. 2
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GROUNDING ELECTRODE DETAIL NO. 1

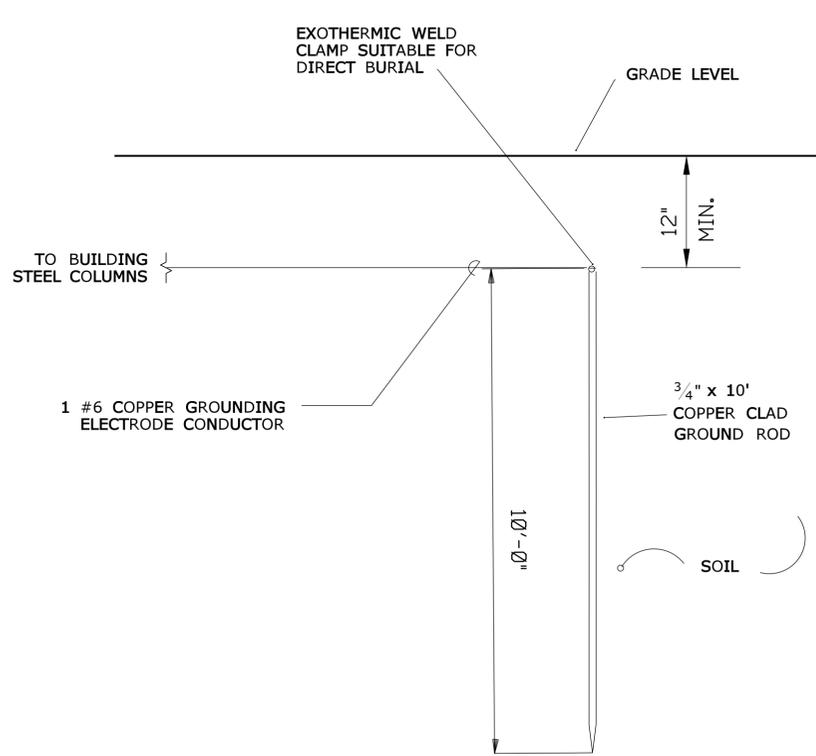NOT TO SCALE



GROUNDING ELECTRODE DETAIL NO. 2

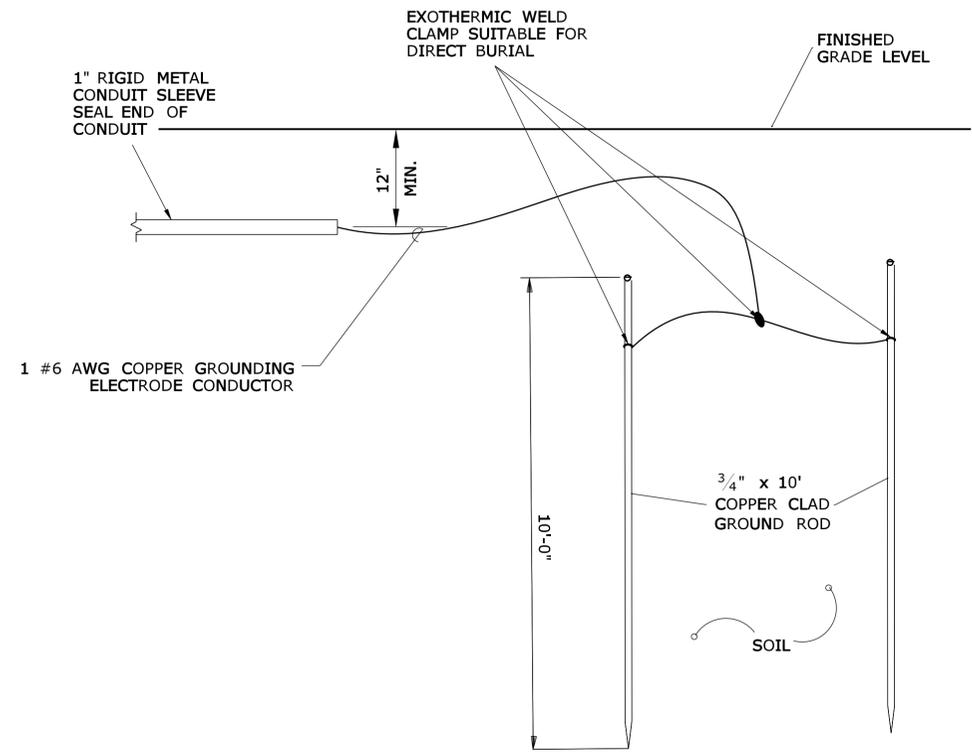NOT TO SCALE

INSTALLATION NOTES:


1. THE STEEL FRAMEWORK OF THE BUILDING SHALL BE GROUNDED WITH A DRIVEN GROUND ROD AT LOCATIONS SHOWN.
2. INSTALL GROUND RING 3 FEET FROM BUILDING AND 30 INCHES MINIMUM BELOW FINAL GRADE. COORDINATE WORK WITH PAVING AND STRUCTURAL WORK.
3. ALL GROUND CONDUCTORS SHALL BE CONCEALED.
4. THE STEEL FRAMEWORK OF THE BUILDING SHALL BE GROUNDED WITH A DRIVEN GROUND ROD AT THE BASE OF EVERY CORNER COLUMN AND AT INTERMEDIATE EXTERIOR COLUMN AT DISTANCES NOT MORE THAN 60 FEET APART.

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THE INFORMATION, INCLUDING ESTIMATED QUANTITIES OF WORK, SHOWN ON THESE SHEETS IS BASED ON LIMITED INVESTIGATIONS BY THE STATE AND IS IN NO WAY WARRANTED TO INDICATE THE CONDITIONS OF ACTUAL QUANTITIES OF WORK WHICH WILL BE REQUIRED.

Plotted Date: 9/14/2009

DESIGNER/DRAFTER: -
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 SCALE AS NOTED

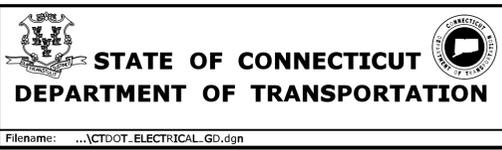


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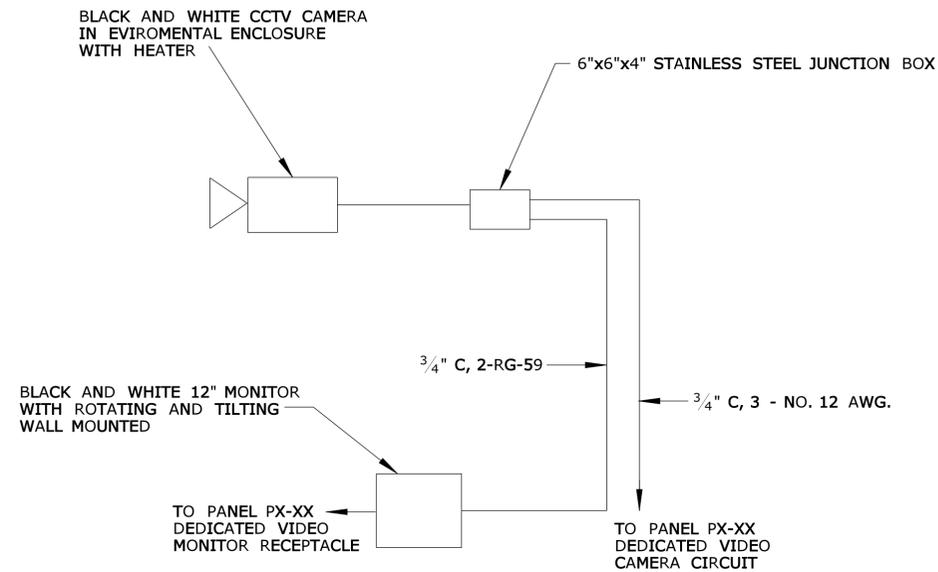
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 DRAWING TITLE: **GROUNDING AND BONDING DETAILS**

PROJECT NO. -
 DRAWING NO. **E-018**
 SHEET NO. **3**




CCTV MONITOR MOUNTING DETAIL
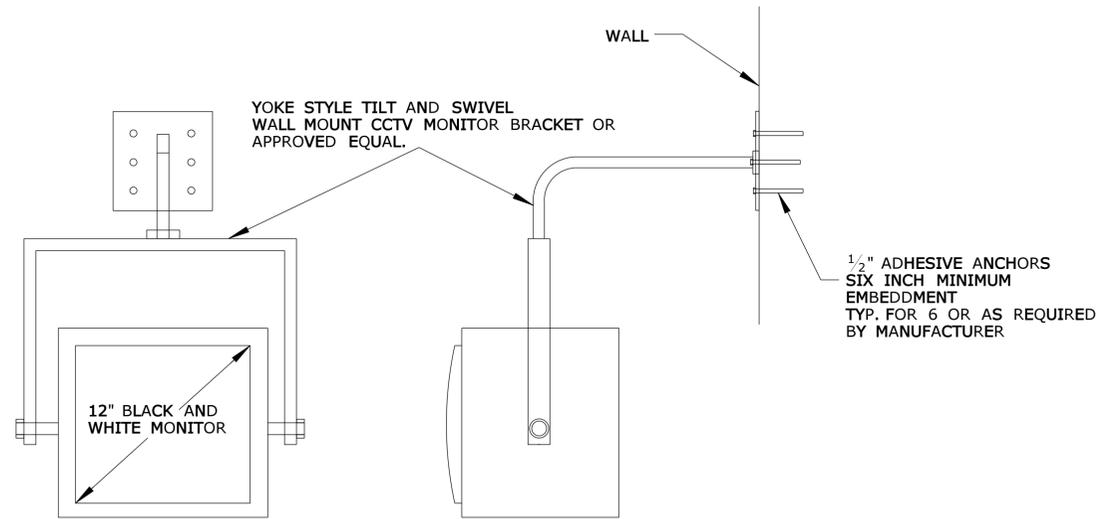
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CCTV BLOCK DIAGRAM

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WALL MOUNTED CCTV CAMERA

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STATE OF CONNECTICUT
DEPARTMENT OF TRANSPORTATION


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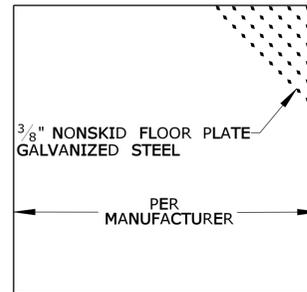
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 DRAWING TITLE: -
CCTV DETAILS

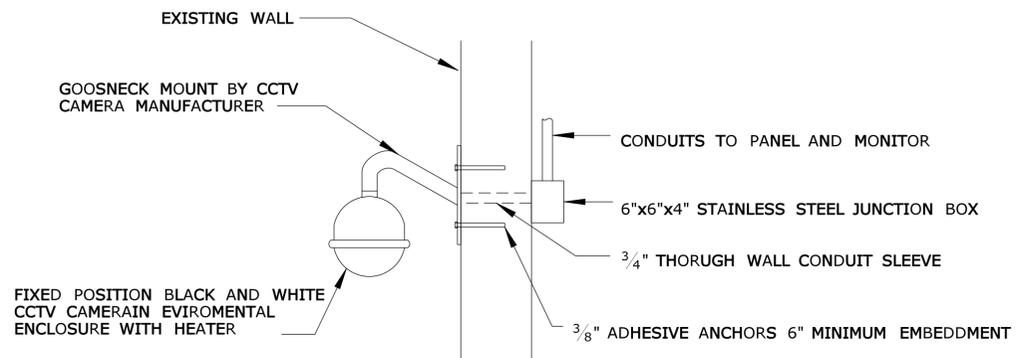PROJECT NO. -
 DRAWING NO. **E-019**
 SHEET NO. **4**



VOICE AND DATA WALL SET-UP

NTS

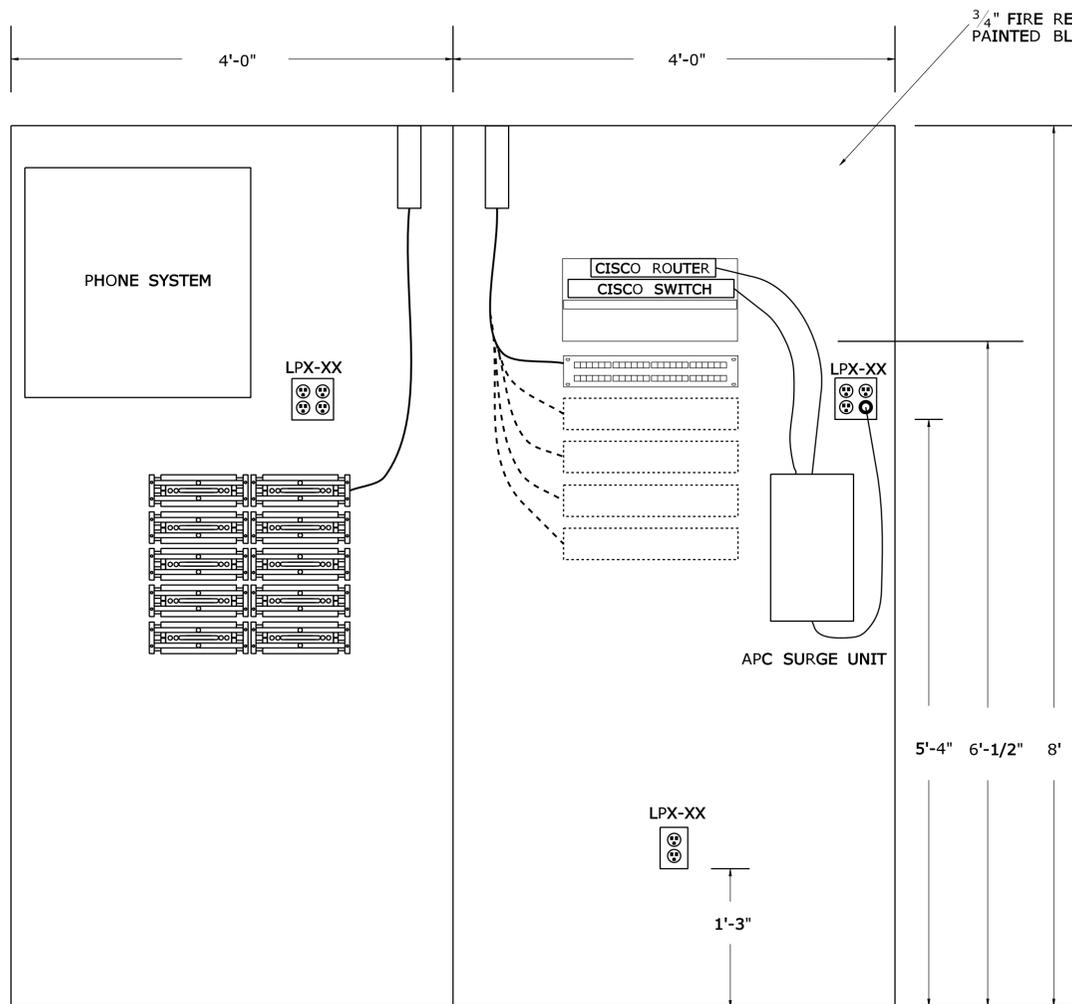


HANDHOLE COVER DETAIL NO. 1

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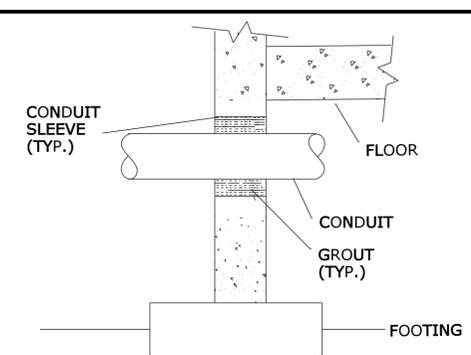
HANDHOLE INSTALLATION NOTES:

1. BLOCK UNUSED OPENINGS OF HANDHOLE.
2. GROUT AROUND ALL CONDUITS.
3. INSTALL THE CENTER OF ALL TYPE II HANDHOLES 3 FEET FROM BACK EDGE OF CURB OR EDGE OF ROAD.
4. INSTALL CENTER OF ALL 30" X 30" HANDHOLES 3 FEET FROM BACK EDGE OF CURB OR EDGE OF ROAD (UNLESS DIMENSIONED OTHERWISE ON THE PLANS).
5. CONTRACTOR SHALL RECEIVE ENGINEERS APPROVAL IN DETERMINING BEST METHOD OF INSTALLING HANDHOLE DRAINS PRIOR TO INSTALLATION OF SUBJECT DRAINS.
6. DUCT SEAL ALL CONDUITS HOUSING CONDUCTORS, AND CAP ALL SPARE CONDUITS.
7. HANDHOLE SHALL MEET UTILITY SPECIFICATIONS.

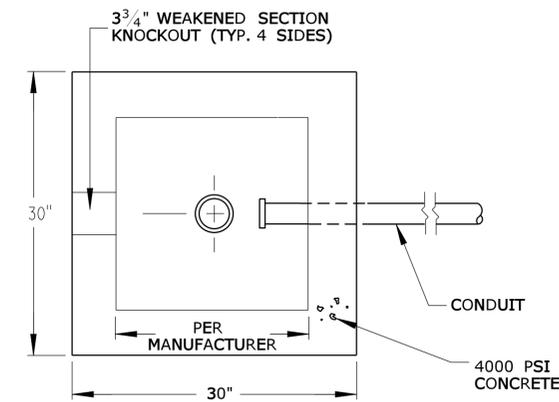


PLAN VIEW DETAIL NO. 2

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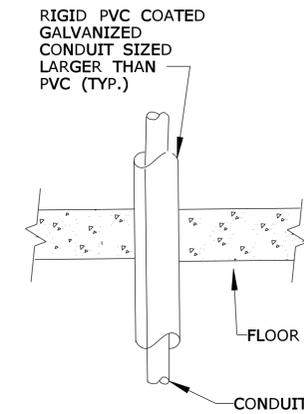
WALL PENETRATION DETAIL NO. 4

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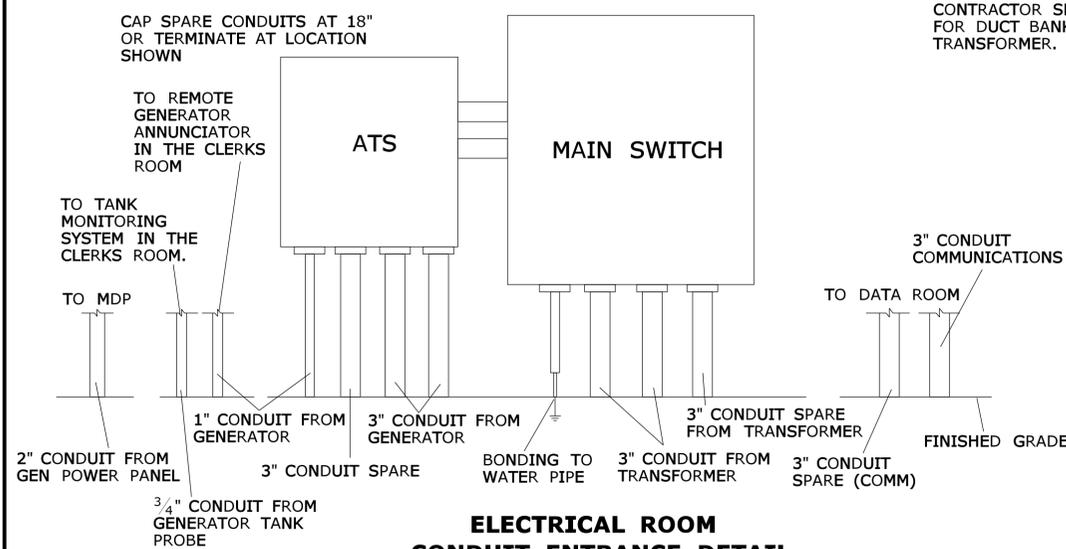
30" X 30" CONCRETE HANDHOLE DETAIL NO. 3

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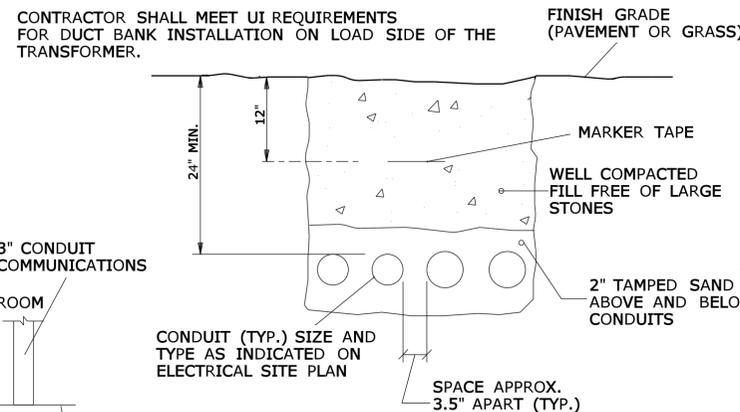
FLOOR PENETRATION DETAIL NO. 5

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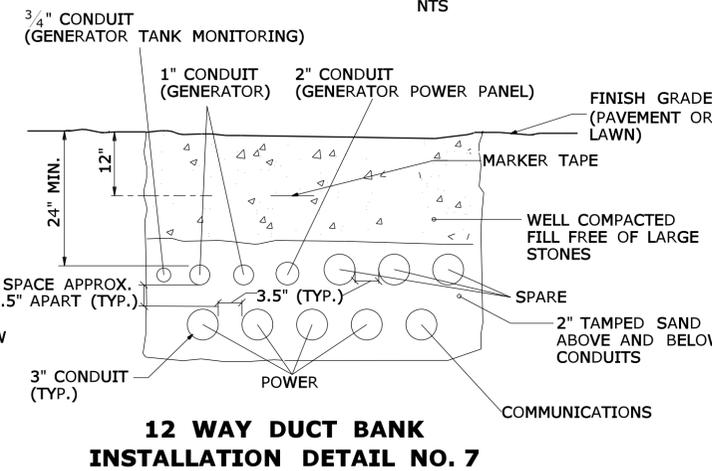
ELECTRICAL ROOM CONDUIT ENTRANCE DETAIL

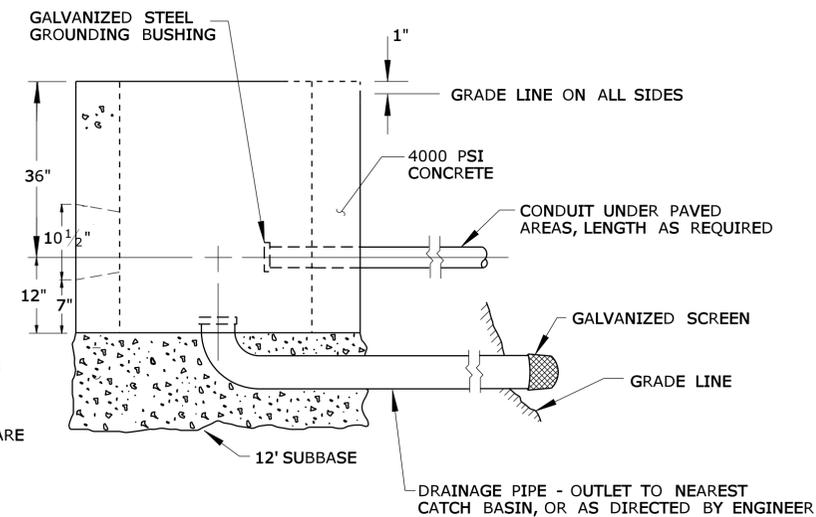NTS




4 WAY DUCT BANK INSTALLATION DETAIL NO. 6

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12 WAY DUCT BANK INSTALLATION DETAIL NO. 7

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CONDUIT INSTALLATION DETAIL NO. 8

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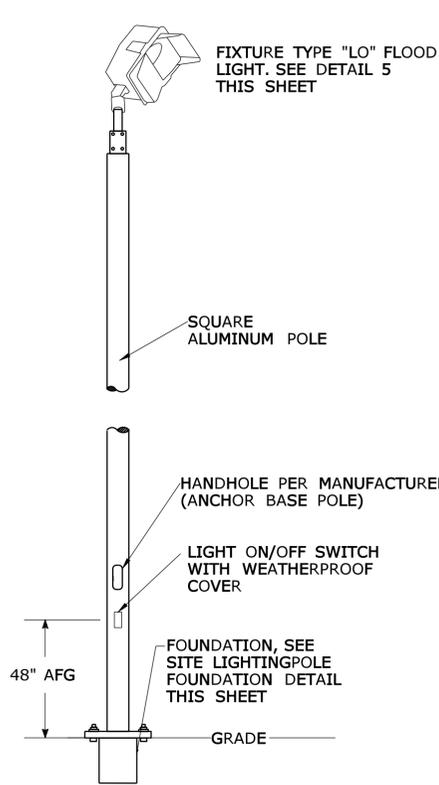
STATE OF CONNECTICUT
DEPARTMENT OF TRANSPORTATION

File name: ...CTDOT_ELECTRICAL_GD.dgn

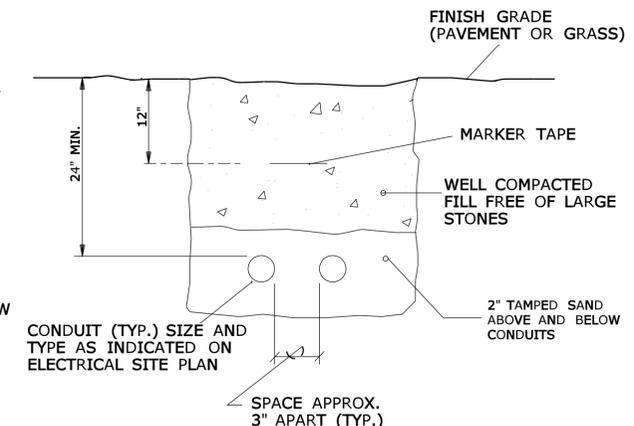OFFICE OF ENGINEERING
 APPROVED BY: _____ DATE: _____


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TOWN:
DRAWING TITLE:
ELECTRICAL DETAILS-1

PROJECT NO.	-
DRAWING NO.	E-020
SHEET NO.	5




SITE LIGHTING FIXTURE -TYPE "LO" WITH SINGLE FIXTURE BRACKET
DETAIL NO. 1

NOT TO SCALE

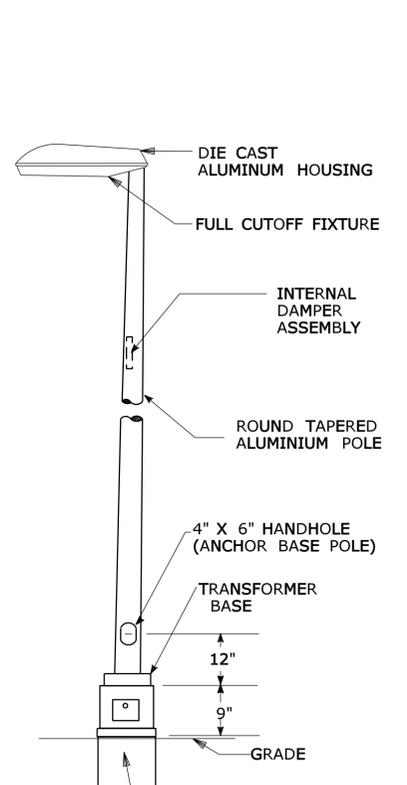


SITE LIGHTING FIXTURE -TYPE "L1" AND "L2" POLE
DETAIL NO. 2

NOT TO SCALE

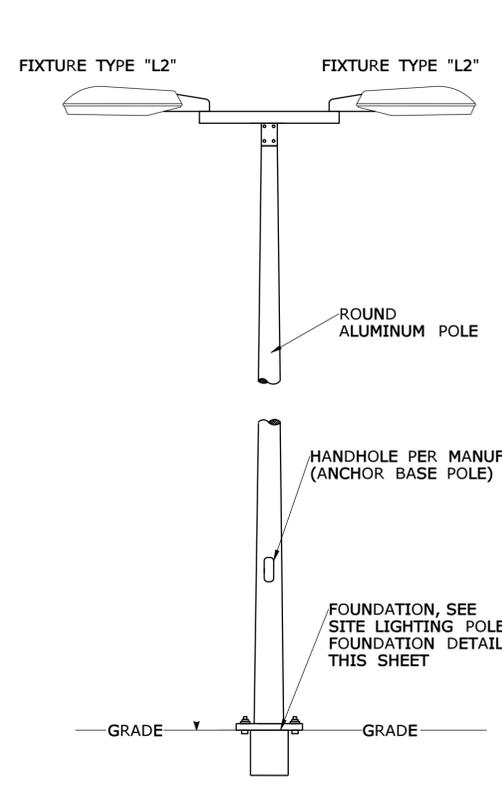


SITE LIGHTING FIXTURE -TYPE "L2/L2" WITH 2 FIXTURE BRACKET
DETAIL NO. 3

NOT TO SCALE

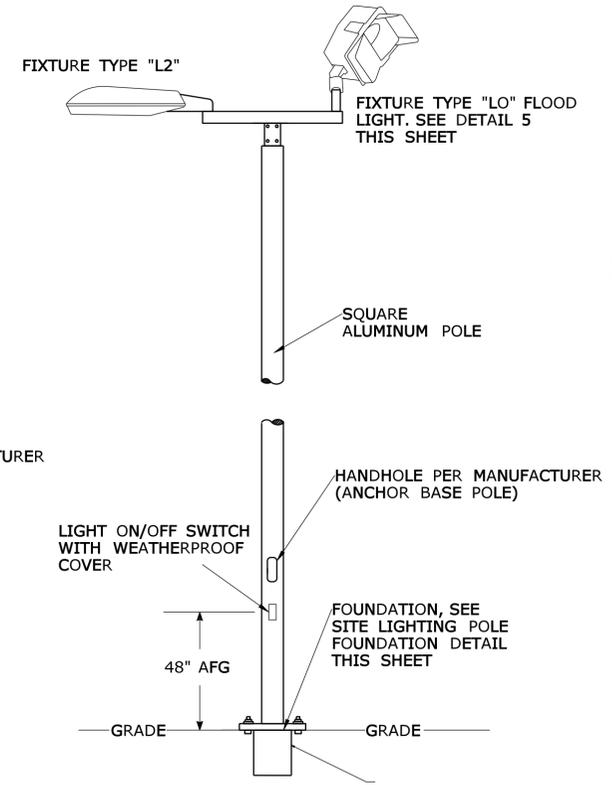

SITE LIGHTING FIXTURE -TYPE "LO/L2" WITH 2 FIXTURE BRACKET
DETAIL NO. 4

NOT TO SCALE

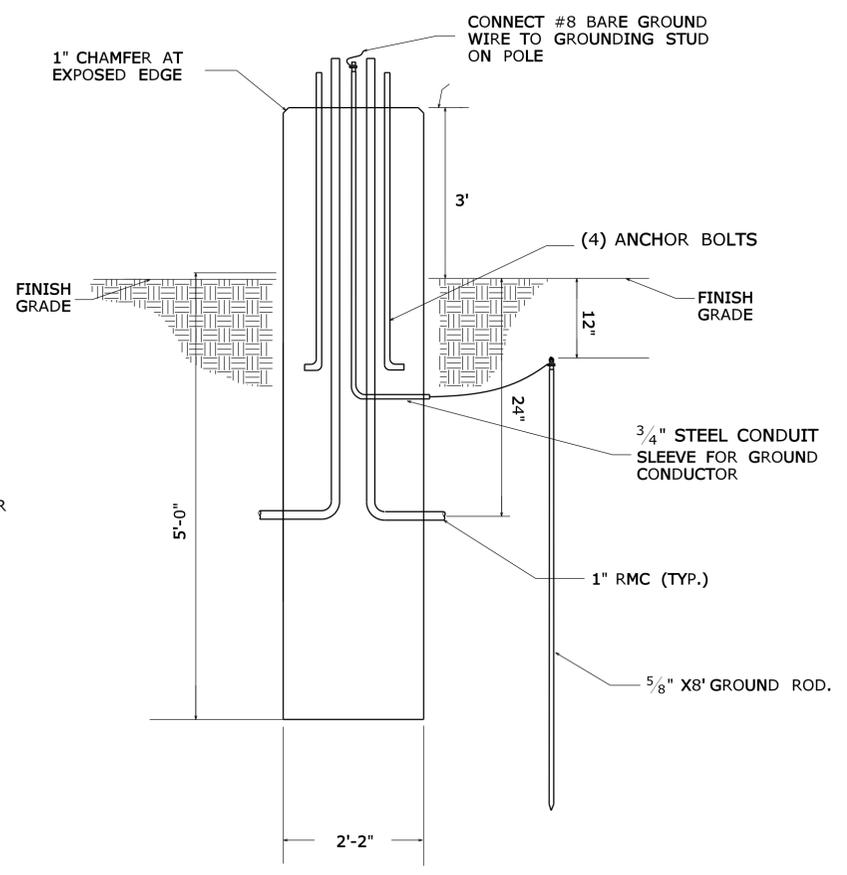


SITE LIGHTING POLE FOUNDATION IN PAVEMENT
FRONT VIEW - DETAIL NO. 7

NOT TO SCALE

DRAWING NOTES:



- EQUIP SITE LIGHTING LUMINAIRES WITH SEPERATE BOND AND GROUND LUGS.
- ALL POLL DIMENTIONS ARE SHOWN ON LIGHTING SCHEDULE. REFER TO DRAWING NO. E-XXX.

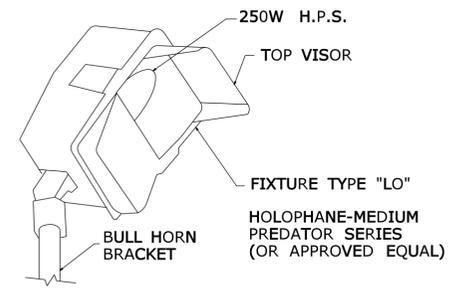


FIXTURE TYPE "LO" FLOOD LIGHT -
DETAIL NO. 5

NOT TO SCALE

DEVICES LOCATED INSIDE NEMA 1X LIGHTING CONTROL PANEL FOR USE IN MAINTENANCE BUILDING

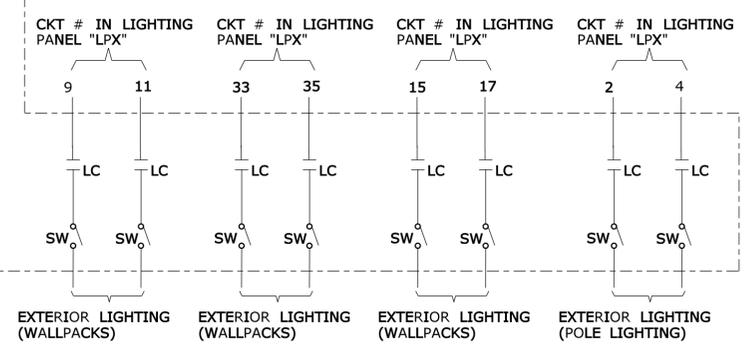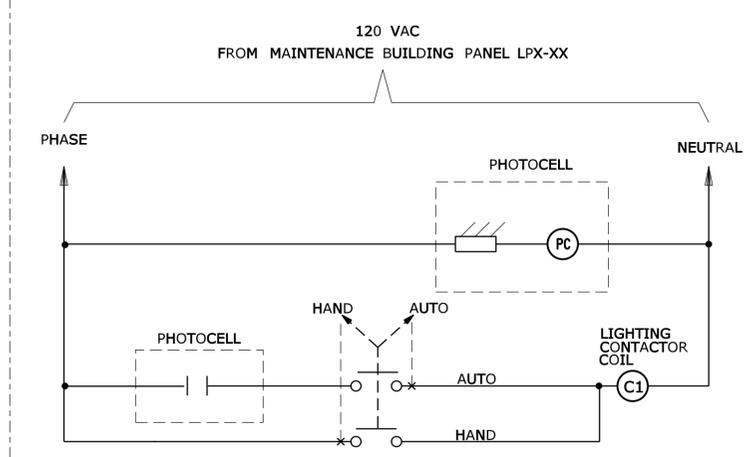


EXTERIOR LIGHTING (WALLPACKS) EXTERIOR LIGHTING (WALLPACKS) EXTERIOR LIGHTING (WALLPACKS) EXTERIOR LIGHTING (POLE LIGHTING)

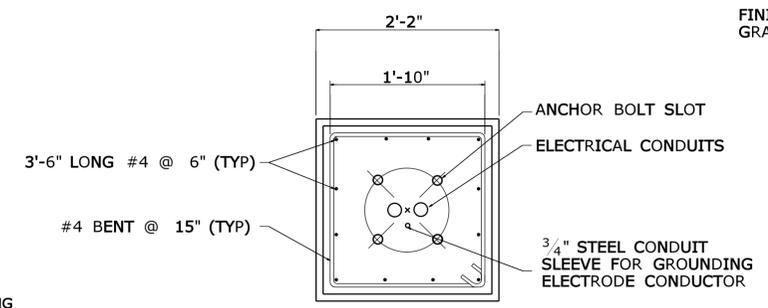

NOTE: FACTORY SUPPLIED TEMPLATES MUST BE USED WHEN SETTING ANCHOR BOLTS, FIELD VERIFY DIMENSIONS BEFORE CONSTRUCTION.

SITE LIGHTING POLE BASE PLATE FOR "LO" AND "L1" LIGHT FIXTURES
DETAIL NO. 6

NOT TO SCALE

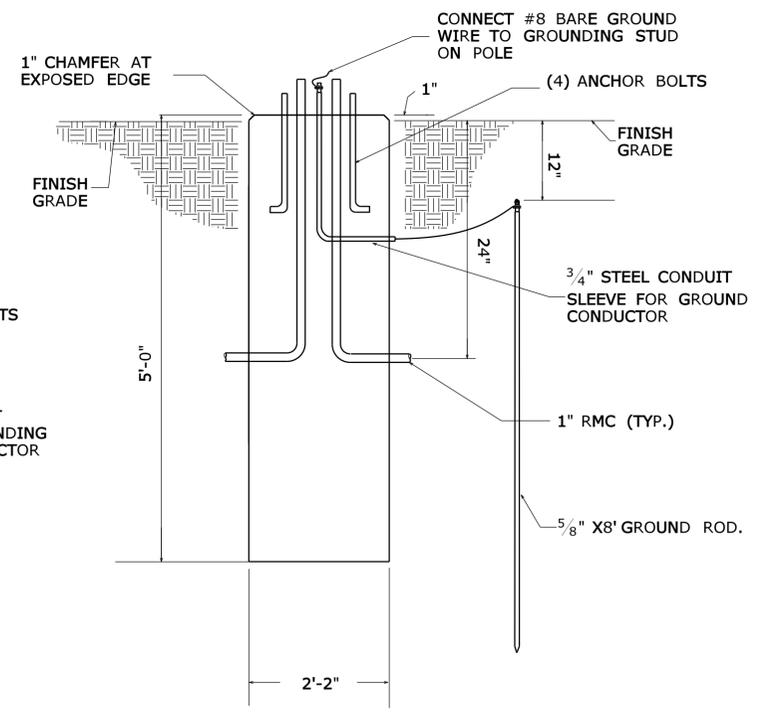

SITE LIGHTING POLE FOUNDATION IN GRASS
FRONT VIEW - DETAIL NO. 8

NOT TO SCALE

REV.	DATE	REVISION DESCRIPTION	SHEET NO.
-	-	-	-
-	-	-	-
-	-	-	-
-	-	-	-
-	-	-	-
-	-	-	-

THE INFORMATION, INCLUDING ESTIMATED QUANTITIES OF WORK, SHOWN ON THESE SHEETS IS BASED ON LIMITED INVESTIGATIONS BY THE STATE AND IS IN NO WAY WARRANTED TO INDICATE THE CONDITIONS OF ACTUAL QUANTITIES OF WORK WHICH WILL BE REQUIRED.

DESIGNER/DRAFTER: -
CHECKED BY: -
SCALE AS NOTED

Plotted Date: 9/14/2009

STATE OF CONNECTICUT
DEPARTMENT OF TRANSPORTATION

Signature/Block: -
APPROVED BY: - DATE: -

Filename: ...CTDOT-ELECTRICAL_GD.dgn

PROJECT TITLE: -

OFFICE OF ENGINEERING

TOWN: -

DRAWING TITLE: -

ELECTRICAL DETAILS-2

PROJECT NO. -
DRAWING NO. **E-021**
SHEET NO. **6**